Recreational Camp Review Request

Additional Items

Cedar Mountain Glampground Getaway

located at

8800 S 36150 W, Fruitland, Utah

See Drawing No. 2, "Overview of Proposed Cedar Mountain Glampground" for location of the tent pads, toilet and shower units, cistern, pumphouse, and storage container at the campground.

An emergency vehicle turn around, with a radius of 52', has been constructed at the southeast corner of the property, with assess from Something Road.

A parking area for campground patrons will be constructed.

A 3400 gallon undergound cistern system, that will hold potable water for campground use, is located close to the service road for easy access by a licensed water delivery contractor. A *Request to Haul Water as a Water Source* is included with this Recreational Camp Review Request

A septic system, sized to accommodate **fifteen** campers per day, will be installed. An *Application for Construction Permit* for the septic system is included with this Recreational Camp Review Request.

A 1 1/4" waterline will convey water from the cistern to the pumphouse. A photo voltaic inverter system, located at the pumphouse, will provide power for the water pressure pump, the water heater, and some lighting for the campground.

A campground host will oversee the timely removal of solid wastes, and will provide maintenance of the facility.


Testing of water quality will be conducted as required by Tri County Health Department.

There will be no food service, or pool and spa, at this campground.

APPROVED
by TriCounty Health Dept.

Smill William 10/18/24

Updated: 09 Oct 2024

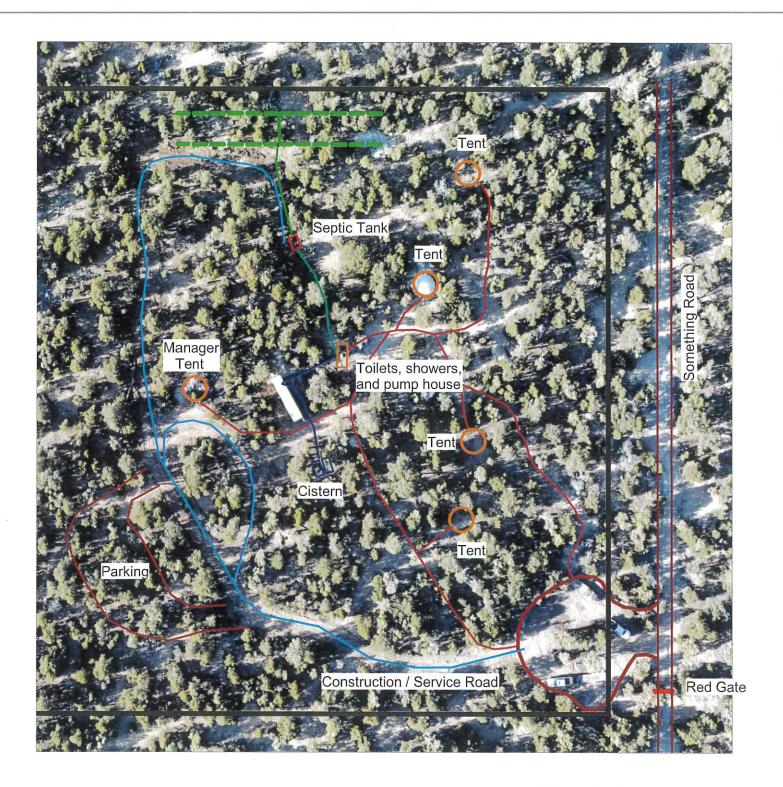



Drawing No.

2

Page No.

Neecholl Vass 8800 S 36150 W (Something Road) Fruitland, Utah

> Drawn: 22 Jun 2024 Updated: 09 Oct 2024

Overview of Proposed Majestic Cedars Glampground

Scale: 1" = 80'
Photo = 2024 13 Sep (RainDance Drone)



RainDance

APPLICATION FOR ON-SITE WASTEWATER PERMIT

OWNER APPROVAL SIGNATURE PAGE

The property owner has ultimate responsibility for the design, installation, operation and maintenance of the on-site wastewater system.

Property owner's signature is required on two documents within the Application, first on the Application Page, and again on the Plot Plan Page.


Property owner's signature on this page certifies that owner has reviewed the attached **Application for Onsite Wastewater Permit** page, and the Septic System Design and specifications pages, and will construct the system as described therein, and will operate and maintain the system in accordance with the design and specifications, as approved by Tri County Health Department.

Property owner's signature on this page also certifies that owner has reviewed the **Plot Plan** page of this application, is aware of the Water Source Protection Buffer zone, if applicable, and approves of the project layout on the property.

PROPERTY OWNER SIGNATURE:


Date: 23 Aug 2024

Application will not be accepted by Tri County Health Department without a signature.

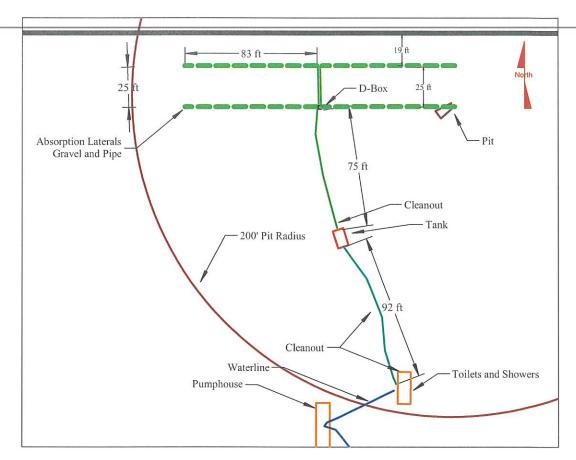

This system is designed for a campground bathhouse that will have 15 campers per day. The design flow is 450 gallons per day, with a hydraulic loading rate of .45 gallons per sq ft per day.

- 1 Tank shall be a minimum of 1000 Gallons. Risers shall bring tank access lids to, or within at least 6" of, final grade.
- 2 Tank shall be installed level and according to manufacturer's instructions.
- 3 All solid pipe shall be 4" PVC Sewer Pipe, ASTM d-3034, and all fittings will be 4" PVC, ASTM d-2665.
- 4 All solid pipe shall slope at least 1/4" per foot. (A 10' run drops 2.5", 20' drops 5")
- 5 A distribution box shall be used to divide effluent.
- 6 Inspection cover for distribution box must be at finished grade level. Use risers as needed.
- 7 Absorption trenches shall be of "Standard" pipe and gravel construction.
- 8 Perforated pipe shall be 4" PVC Pipe, ASTM d-2729. Drain media shall be 3/4" to 2 1/2" gravel.
- 9 Level trenches shall be 24" deep, with 6" of gravel below pipe. (See Cross Section Drawing)
- 10 Maximum absorption trench depth is 24" below orginal grade.
- 11 4" perforated pipe shall be placed on 6" of gravel, and then 6" more gravel placed in the trench.
- 12 A geotextile fabric shall be placed over gravel before native fill is placed in the trench.
- 13 There shall be 4 laterals, each 83' long, for a total length of 332', and 1000 sq. ft.
- 14 Lateral trenches shall be 25' apart, on centers. About 50 yds of gravel required for trenches.
- 15 Replacement area is between laterals and 13' north of laterals.
- 16 Replacement area must be reserved for future drainfield construction if needed.
- 17 Culinary waterlines shall not be within 10' of any portion of the septic system or sewer lines.

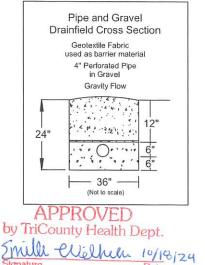

See "Detailed System Design", pages 1 and 2, for design criteria, bill of materials, and other specifications.

No.

3
Page No.
A

Neecholl Vass

8800 S 36150 W (Something Road)
Fruitland, Utah

Drawn: 02 Aug 2024 Updated: 09 Oct 2024

Septic System Design

Scale: 1" = 60'

Design Certified by: Keith Goodspeed Certification Number: 00052 - OSP - 3

Designer Signature: R Keith Goodspeed



R & N Agency Project (Rich Vass)

Campground Project Design Factors

09-Oct-2024

CODE

(as of 01 September 2013)

R317. Environmental Quality, Water Quality. R317-4. Onsite Wastewater Systems.

TABLE 3

Estimated Flow Rates of Wastewater

Type of Establishment Gallons per day

Camps

a. with showers and flush toilets 30 per person

HYDRAULIC LOADING RATES

TABLE 5 - Maximum Loading Rates for Perc Test

Perc. Rate	Gallon/Sq Ft/Da		
1-10	.90		
11-20	.70		
21-30	.60		
31-40	.55		
41-50	.50		
51-60	.45		
61-90 (I)	.40		
91-120 (I)	.35		

TABLE 6 - Maximum Loading Rates for Soil Classification

Texture	Structure	Gallon/Sq Ft/Day	
Silt Loam	Massive	(e)	
	Platy	(e)	
	Prismatic, blocky, granular	.45	

(c) For non-residential facilities, a minimum of 150 square feet of trench bottom or sidewall absorption area shall be provided.

Septic Tank Sizing

6.7.A.1. A septic tank that serves a non-residential facility shall have a liquid capacity of at least 1-1/2 times the designed daily wastewater flow. In all cases the capacity shall be at least 1,000 gallons.

Note:

CALCULATIONS

Daily Flow:

Table 3 indicates that Camps with showers and flush toilets use an estimated quantity of 30 gallons per person per day.

The owner estimates there will be 15 campers using the facility.

30 gallons X 15 persons = 450 gallons per day

This design will be based on a flow 450 gallons per day.

Drainfield Sizing:

Hydraulic loading rate in gallons/sq. ft./day is 0.45

Minimum absorption area is equal to daily flow divided by the loading rate.

450 gallons / day divided by 0.45 gallons /sq. ft./day = 1,000 sq. ft.

No reduction of absorption are when using gravel and pipe.

1,000 sq. ft. times 1 = 1,000 sq. ft. = Drainfield Size

Table 6, footnote c, says minimum absorption area is 150 sq. ft.

Mimimum design size is 1,000 sq. ft.

Required	Trench	Linear	Number of	Lateral
Sq. Ft.	Width	<u>Feet</u>	<u>Laterals</u>	Length
1,000	3	333	4	83

Yards of Gravel = 37 round to -->) 50

Drainfield Size:

Number of Laterals:

Length of each Lateral: 83 Feet

Total Square Footage: 1,000 Sq. Ft.

Tank Size:

450 gpd flow = 1000 Gallon Tank

Floor drains in industrial buildings, shops, or garages are not allowed to connect to septic system!!!

Parking or traffic are not allowed over any portion of the septic system!!!

Appropriate barricades need to be placed to keep vehicles away.



<u>Detailed System Design - Page 2</u>

Materials -

Quantity Unit 1 Ea Tank Size & Manufacturer: 1000 Gallon Tank, Low Profile, Norwesco 2 Ea Riser: 24" Tank Opening Riser 1 Ea D-Box 7 Hole, 20" Distribution Box, Polylok, Part # 3017-207 1 Ea D-Box Cover Heavy Cover, 20", Polylok, Part # 3017-C20 D-Box Riser 12" Riser for 20" D-Box, Polylok, Part # 3009-R12 1 Ea 200 Ft Pipe Size & Schedule: 4" PVC, ASTM 3033 or 3034 350 Ft Absorption Trench Pipe: 4" PVC, Perforated, ASTM 2729 2 Ea Elbow, 90 Degree, 4" PVC, ASTM D 2665 4 Fa 4" Cap, Sewer IPS Weld-On 711 or equal 1 Qt 1 Qt IPS Weld-On P 68 Primer or equal 3 Fa Cleanout Fittings: 4" Wye, Sewer 3 Ea Cleanout Fittings: 4" Street EI, 45 Degree 3 Ea Cleanout Fittings: 4" Female Adapter 3 Еа Cleanout Fittings: 4" Plug, Threaded 50 Yd Drain Media: Gravel 350 Ft Separation Material: Geotextile Fabric - 3' Wide

Details -

Plan: See Drawing

Water Supply: Haul Watercourse, lake, etc: None Curtain Drains None

Property Lines See Plot Plan Drawing

Between Trenches: 25'
Length of Trenches: 83'
Slope or Embankment: Negligible
Between Tank & Trenches: 80'

Location of Observation Hole: See Drawing Location of Perc Test Hole: See Drawing

Easements & Right-of-Ways: None

Replacement Area: Between laterals and north of drainfield (See Drawing)

Slope of Building Sewer: Minimun Slope of 1/4" per foot Slope of Laterals: No Slope. Install level.

Roadways, Driveways, etc.: See Drawing

Trench -

Depth and Width: 24" Deep by 36" Wide

Depth of Pipe: 18"

Barrier Material: Non woven geotextile fabric

Depth of Drain Media: 12" Depth of Backfill: 12"

Maximum Depth of Trenches: 24"

Other -

Cleanouts: R 317-4-6.1.H. The lines shall have cleanouts every 100 feet and at

all changes in direction or grade, except where manholes are installed every 400 feet and at every change in direction or grade. On four-inch and six-inch lines, two 45 degree bends with cleanout will be acceptable in lieu of a manhole, and 90 degree ells are not

recommended.

Tank Cover: R 317-4-7.17.C. The top of the tank shall be at least six inches below

finished grade.

Risers: R 317-4-7.17.D. All manholes required by R317-4-7 shall be extended

to within at least six inches of the finished grade.


Water Lines: R 317-4-4.3, Table 2 - Minimum distance from Culinary Water

Supply Line to Building Sewer, Tank, and Absorption Trench is 10

feet.

R 317-4-4.3, Table 2, footnote (g)..... no water service line shall pass over any portion of an onsite wastewater system.



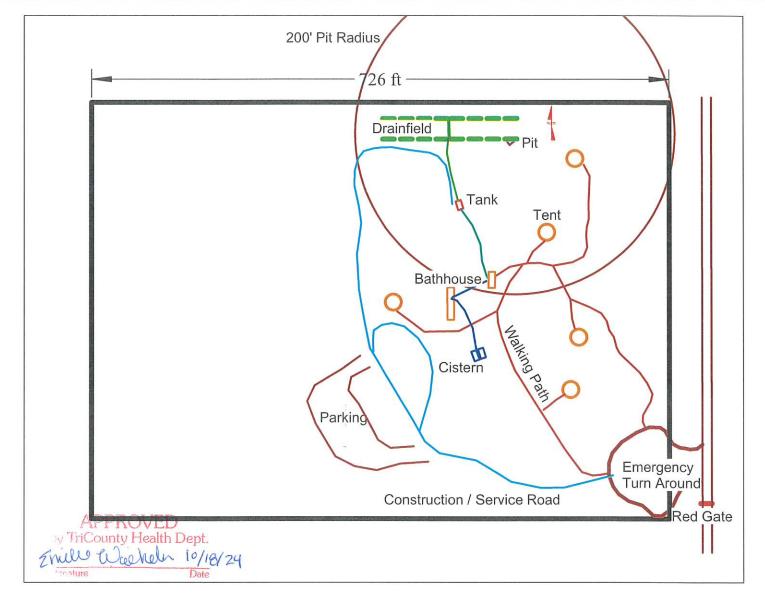

Cedar Mountain Glampground Getaway

See Drawing No. 3, "Septic System Design", for Detailed Dimensions


Owner's Signature:

(See Signature Page)

This property is Serial # CMT-0003-0011, and Parcel # 00-0008-8058, in Duchesne County.

This property is located in Section 33, Township 3 S, Range 7 W, Uintah Basin Special Meridian.

This lot is 9.95 acres in size.

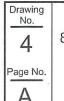


Neecholl Vass 8800 S 36150 W (Something Road) Fruitland, Utah

Drawn: 02 Aug 2024 Updated: 09 Oct 2024

Plot Plan

Scale: 1" = 120'



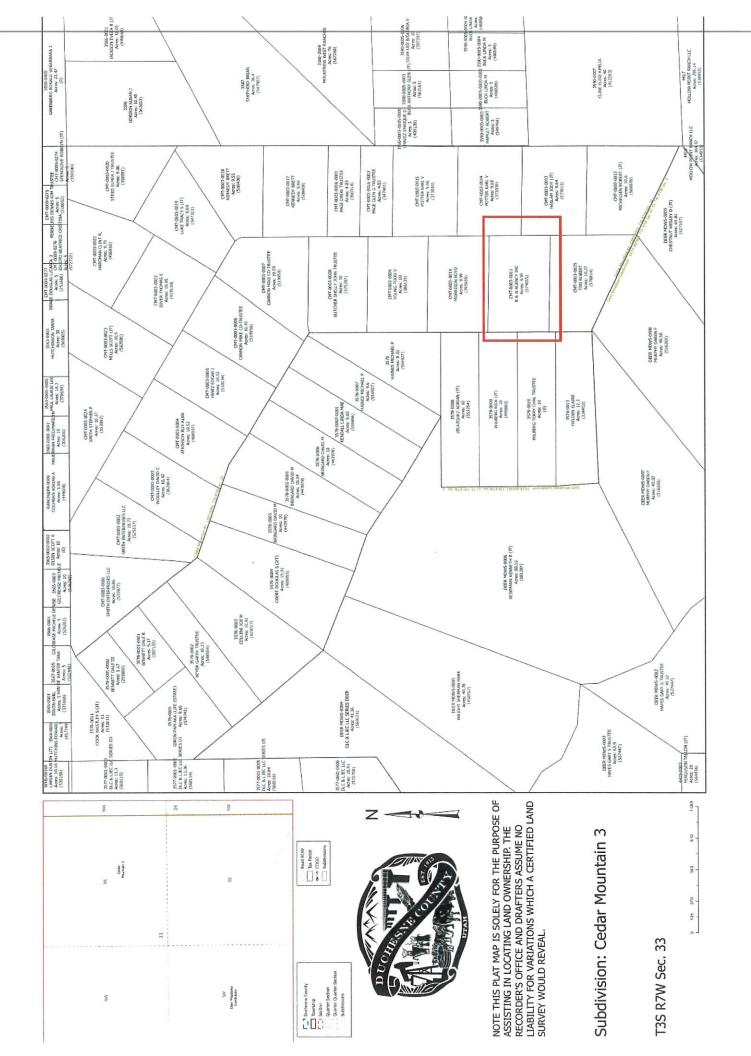

Floor Plan

The dwelling units at this campground will be tents.

The bathhouse at this campground will contain toilets, washbasins, and showers.

See *Recreational Camp Plan Review Request* for the Cedar Mountain Glampground Getaway for more information.





Uintah County 133 South 500 East Vernal, UT 84078 (435) 247-1177

Duchesne County 409 South 200 East Roosevelt, UT 84066 (435) 722-6300

Kirk Benge, M.P.H Director/Health Officer

10/18/2024

Richard Vass / R & N Agency 221 Backhand Lane Lehi, UT 84043

ONSITE WASTEWATER PERMIT:# 2024-DUWW-2001459861 "C"

MAXIMUM USE: 20 EMPLOYEES/ 450 GPD REGISTERED INSTALLER: Keith Goodspeed

RE: ONSITE WASTEWATER SYSTEM CONSTRUCTION PERMIT SITE LOCATION: Lot 11 Cedar Mt #3 ,SEC 33, T3S, R7W, USM

SERIAL #: CMT-0003-0011

Dear Client,

A review of plans and supporting information submitted for a proposed onsite wastewater system to serve the above referenced location has been conducted.

The plans appear to be in accordance with Utah Administrative Code R317-4, Onsite Wastewater Systems, and are approved subject to any notations that may be listed below. One set of the application materials is being retained for our file information.

Enclosed is a copy of the stamped approved plans, which together with this letter, constitutes an onsite wastewater permit. This permit is valid for one year from the date of issue. If authorized work has not commenced or if construction work is suspended or abandoned for a period of one year, this permit will become null and void.

Utah law required all domestic wastewater (bathroom, kitchen, laundry wastes, etc.) to be disposed of into an approved onsite wastewater system. Any proposed alterations to the approved plans must be submitted and approved prior to construction. After construction and prior to backfill of the system, an inspection must be performed by the health authority. Please allow 5 working days' notice for the inspection. Failure to have the system inspected is a violation of Utah's Health Rules and is subject to legal action.



Uintah County 133 South 500 East Vernal, UT 84078 (435) 247-1177

Duchesne County 409 South 200 East Roosevelt, UT 84066 (435) 722-6300 **Kirk Benge, M.P.H**Director/Health
Officer

REQUIREMENTS:

- To be installed by Keith Goodspeed per TCHD-WW-00317
- All water wells/springs must be tested for potability prior to an operating permit being issued.
- All culinary connections must be purchased prior to an operating permit being issued.
- A copy of the approved plans must be on site in possession of the person constructing the onsite wastewater system.
- Septic tank must pass a leak test by holding water for a 24-hour period of time prior to inspection.


Sincerely,

Emilee Wilhelm, L.E.H.S

Enclosure

Cc:

Duchesne County County Building Official Designer - Keith Goodspeed Installer - Keith Goodspeed Client File Correspondence File

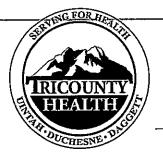

133 South 500 East Vernal, UT 84078 (435) 247-1177

Duchesne County 409 South 200 East Roosevelt, UT 84066 (435) 722-6300



Kirk Benge, M.P.H. Director/Health Officer TRICOUNTYHEALTH.COM

October 18, 2024

Neecholl Vass 221 E Backhand Lane Lehi, UT 84043

RE:

RECREATIONAL CAMP PLAN APPROVAL FOR CEDAR MOUNTAIN

GLAMPGROUND GETAWAY

SITE LOCATION:

LOT 11 CEDAR MT #3, DUCHESNE COUNTY, UT

PROPERTY S/N:

CMT-0003-0011

Dear Sir/Madam:

TriCounty Health Department has reviewed your plan review application for a recreational camp at the above referenced location. The plans appear to be in accordance with Utah Administrative Rules R392-300 and are hereby approved.

- The onsite wastewater system is sized for 20 people / 450 GPD.
- The campground can accommodate 15 campers.

After construction is complete and prior to opening the campground, you must have an inspection performed by the TriCounty Health Department and obtain an operating permit.

If you have any questions, please call (435) 722-6310

Sincerely,

Émilee Wilhelm, L.E.H.S.

EW/jt

CC:

Duchesne County P & Z

Client File



Uintah County 133 South 500 East Vernal, UT 84078 (435) 247-1177

Duchesne County 409 South 200 East Roosevelt, UT 84066 (435) 722-6300

Kirk Benge, M.P.H. Director/Health Officer

TRICOUNTYHEALTH.COM

Sept 9, 2024

Neecholl Vass 211 E Backhand Ln. Lehi, UT 84043

RE:

PRELIMINARY APPROVAL TO HAUL DRINKING WATER

SITE LOCATION: LOT 11 CEDAR MT #3, DUCHESNE COUNTY, UT

TAX I.D. #:

CMT-0003-0011

Dear Client:

TriCounty Health Department has completed the review of your request to haul water for the above referenced property. Based on the information submitted, TriCounty Health Department hereby grants preliminary approval to haul potable water from Duchesne City Water.

Must submit a will serve water letter from Duchesne City Water.

Must submit location of tank, size, and proof that tank is approved for drinking water.

Final approval cannot be given until an Onsite Wastewater System Construction Permit is issued.

Must submit monthly well water bacteria samples once the recreational camp is approved.

If you have any questions, please call (435) 722-6310 Sincerely,

Joe Hadlock

Environmental Health Director

JH/it

cc:

Duchesne County Building Official

Client File

SERVICE ORDER # SO 0001185 NEW SERVICE OFDER SUBMITTED



Roosevelt City Corporation 255 South State Street Roosevelt, Utah 84066 (435) 722-5001 722-5000 Fax

Email to: truff@rooseveltcity.com



Application for Purchasing Bulk Water Agreement Form

COMPANY NAME:	Cedar Mountain Glampground Getaway			
CURRENT MAILING A	DDRESS FOR BILLING: _	221 Backh	and Lane	
***		Lehi, Utah	84043	
APPLICANT'S NAME:	Neecholl Vass			
CONTACT #:80		Email:	richard.vass@gmail.com	
Deposit will be waived if The deposit will be refun The customer will be bill Payment is due by the 2	ed for each month at the ra 5 th of each month. Service	sly or current se ecount is kept cu ate of \$5.00 /1,0 can be termina	urrent or the account is terminated.	
Neecholl Vas		Date:09 C		
Signature of Applicant	And the second s	Dutc	Application of the second seco	
Send completed form wi Roosevelt City 255 S State Street 36-8	th check to: Signed by		Speed, acting for Neecholl Vass Date: 10 Oct 2024	
Roosevelt, UT 84066			Date: 10 Oct 2024	
The facility is located at Western Petroleum Bulk,	2079 West 1600 South in the and Duchesne County Mos	ne Airport Subdi squito Abatemer	vision. Westside Storage Units, at are some of businesses nearby.	
It is important that your	customer code # is not visi	ble to just anyo	ne.	
If you are experiencing p	problems with the Bulk Wate 435-722-5001 Weekdays	er System, pleas	se contact	
After hours, Weekends a The Dispatch Center will	nd Holidays: Central Dispa notify one of the Public Wo	tch, 435-722-45 orks Department	558. staff member on call for the week.	
Date Service Will St	art:10 Oct 2024			
Bulk Water # Assigi	ned: 1022			
Customer # Assigne Account # (A		the # and infe	nemation.	